GENERAL NOTES:

- 1. DRAWINGS SHOULD BE READ IN CONJUCTION WITH ENGINEERS REPORT.
- 2. WRITTEN DIMENSIONS WILL TAKE PRIORITY OVER SCALED MEASUREMENTS. DIMENSIONS SHOULD BE VERIFIED ON SITE BY BUILDER OR CONTRACTOR PRIOR TO COMMENCEMENT OF ANY WORK.
- 3. ALL WORKS TO COMPLY WITH THE BUILDING CODE OF AUSTRALIA.
 4. ALL WORKS TO BE CARRIED OUT IN ACCORDANCE WITH SA WORK AND SAFETY ACT, REGULATIONS AND CODES OF PRACTICE 2012.
- 5. ALL TIMBER WALL AND ROOFING MEMBERS TO COMPLY WITH THE NATIONAL TIMBER FRAMING CODE AS-1684.2
- 6. ALL WET AREAS TO COMPLY WITH BCA 3.8.1 AND AS3740-2010
- 7. IT WILL BE THE RESPONSIBILTY OF THE ROOFER TO ENSURE THAT THE WHOLE OF THE ROOF IS WATERTIGHT.
- 8. ALL FIXTURE AND APPLIANCES TO BE INSTALLED STRICTLY IN ACCORDANCE WITH THE MANUFACTURERS INSTRUCTIONS.
- 9. ALL STORMWATER SHOULD COMPLY WITH AS- 3500.2 NATIONAL PLUMBING CODE. 90dia UPVC STORMWATER SYSTEM TO BE CONECTED TO DOWNPIPES AND DISCHARGED TO APPROVED COUNCIL OUTLETS.
- 10. WIND SPEED AREA N2 33m/s. ALL WINDOWS AND DOORS TO COMPLY WITH AS 2047- WINDOWS AND DOORS IN BUILDING TO MEET N2 WIND SPEED REQUIREMENTS. ALL GLAZING TO COMPLY WITH AS1288 AND NCC PART 3.6
- 11. DRAUGHT PROTECTION DEVICES TO BE FITTED TO EDGES OF EXTERNAL DOORS.
- 12. (\$) SELF CONTAINED HARD WIRED SMOKE ALARM COMPLYING WITH AS3786 CONNECTED TO CONSUMER MAINS WITH BATTERY BACK UP. SMOKE ALARMS TO BE INTERCONNECTED COMPLYING WITH BCA 2014.
- 13. EFFLUENT TO DISCHARGE TO SA WATER SEWER NETWORK IN ACCORDANCE WITH S.A. HEALTH COMMISSION & COUNCIL REQUIREMENTS.
- 14. NO BRUSH FENCES ARE TO BE WITHIN 3m OF THE BUILDING WORKS.
- 15. ALL ELECTRICAL WORKS SHALL COMPLY WITH AS 3000. ELECTRICAL REQUIREMENTS & LAYOUT TO BE DISCUSSED & CONFIRMED ON SITE WITH
- 16. ALL EXPOSED STEELWORK, LINTELS ETC. SHALL BE HOT DIPPED GALVANISED. ALL BOLTS, NUTS AND WASHERS SHALL BE HOT DIPPED GALVANISED. ALL NAILS SHALL BE GALVANISFD

INSULATION:

ROOFING: R4.1 INSULATION TO CEILING WITH SARKING OVER ROOF PURLINS WALLS: R2.5 WALL BATTS INSULATION TO EXTERNAL WITH SARKING WEATHER BARRIER WALLS UNLESS NOTED OTHERWISE.

R2.0 INSULATION TO INTERNAL WALLS UNLESS NOTED OTHERWISE.

TERMITE TREATMENT:

PROVIDE A TERMITE PROTECTION BARRIER TO AS3660.1 AND INSTALLED TO MANUFACTURER'S SPECIFICATIONS.

NEW BUILDING AREAS:

LIVING: VERANDAS CARPORT: 21m2

CONSTRUCTION NOTES:

DURING CONSTRUCTION AND AT ALL TIMES THEREAFTER, STORMWATER GENERATED FROM THE DEVELOPMENT SHALL BE DIVERTED AWAY FROM ALL BUILDINGS, SHALL NOT POND AGAINST OR NEAR THE FOOTINGS, AND SHALL NOT BE DISCHARGED ONTO ADJOINING LAND.

DURING CONSTRUCTION EFFECTIVE MEASURES MUST BE IMPLIMENTED TO:

- PREVENT SILT RUN OFF FROM THE LAND TO ADJOINING PROPERTIES ROADS AND DRAINS.
- CONTROL DUST ARISING FROM THE CONSTRUCTION AND OTHER ACTIVITIES, SO AS NOT TO, IN THE OPINION OF COUNCIL, BE A NUISANCE TO RESIDENTS OR OCCUPIERS ON ADJACENT OR NEARBY LAND
- ENSURE THAT SOIL OR MUD IS NOT TRANSFERRED ONTO THE ADJACENT ROADWORKS BY VEHICLES LEAVING THE
- ENSURE THAT ALL LITTER AND BUILDING WASTE IS CONTAINED ON THE SUBJECT SITE IN A SUITABLE COVERED BIN OR ENCLOSURE.
- ENSURE NO SOUND IS EMITTED FROM ANY DEVICE, PLANT OR EQUIPMENT OR FROM ANY SOURCE OR ACTIVITY TO BECOME AN UNREASONABLE NUISANCE, IN THE OPINION OF COUNCIL, TO THE OCCUPIERS OF ADJACENT LAND.



SITE PLAN

LEGEND/NOTES

EXISTING DOWNPIPE

• DP DOWNPIPE

90 DIA. PVC SEALED UNDERGROUND STORMWATER PIPE

DENOTES EXISTING DESIGN LEVELS XXX.XX DENOTES NEW DESIGN LEVELS

ALL FINISHED LEVELS TO BE CONFIRMED ON SITE BY OWNER AND BUILDER



PROPOSED AREA OF DEVELOPMENT

REFER TO CERTIFICATE OF TITLE FOR DETAILS REGARDING BOUNDARY DIMENSIONS, ENCUMBRANCES AND EASEMENTS.

SHEET 1 OF 17


PROJECT: Addition to Existing Dwelling

CLIENT: Mike and Trinh Richards

SITE ADDRESS: 5 Shephard Road ALDINGA BEACH SA 5173

Remarks Date Rev. SITE PLAN Issued for Planning Approval SCALE: 1:200 UNO DRAWN BY: S.LAYTON 5 Apr2022 DATE:

steve **layton**design 10 WIGLEY DRIVE McLAREN VALE Mob: 0448 656 254

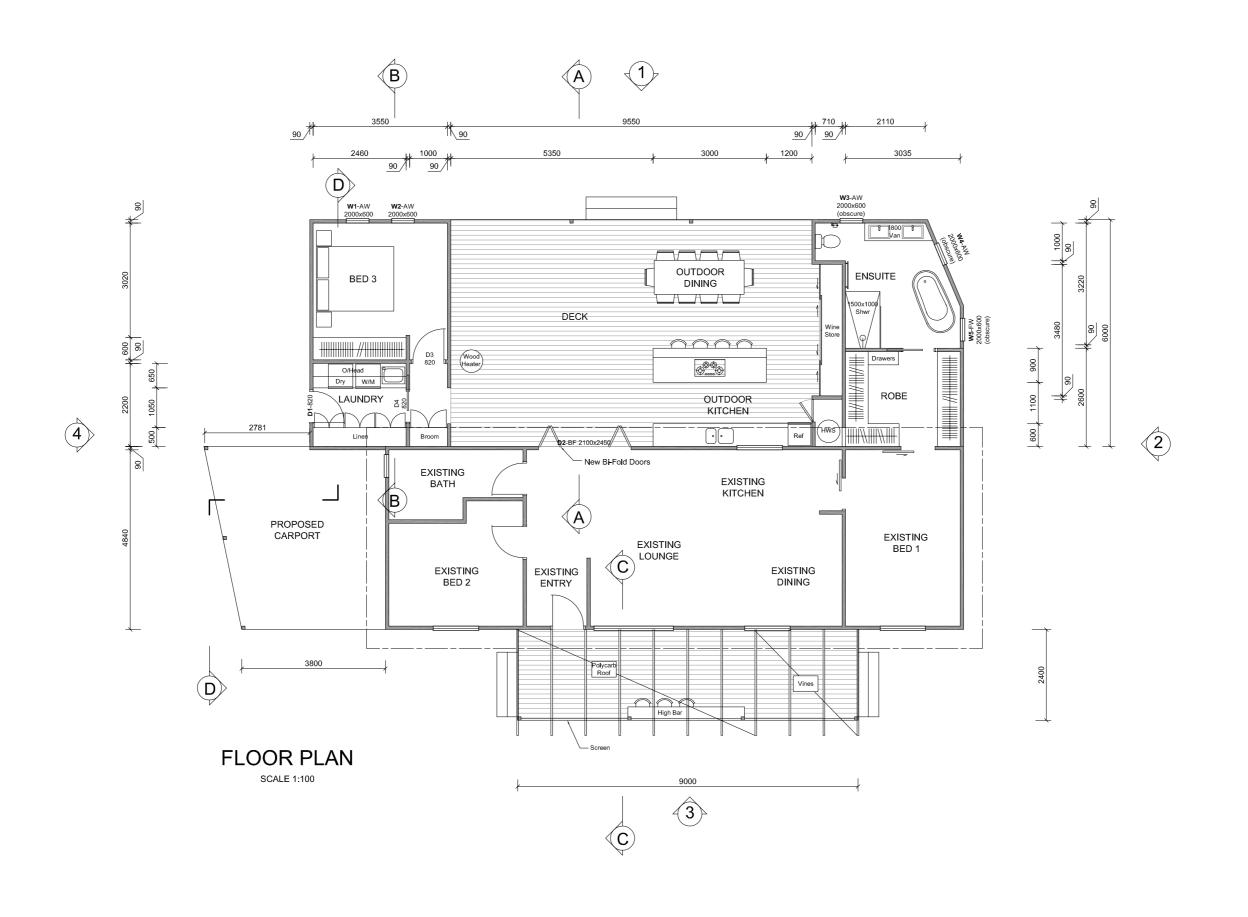

SHEET 2 OF 17

PROJECT: Addition to Existing Dwelling CLIENT: Mike and Trinh Richards

SITE ADDRESS: 5 Shephard Road ALDINGA BEACH SA 5173


FLOOR PLAN


1:100 UNO SCALE: S.LAYTON DRAWN BY: 5 Apr2022 DATE:

Rev.	Remarks	Date	
А	Issued for Planning Approval	5APR22	
В	Issued for Bullding Approval	2Aug22	Ш
			Ш

steve laytondesign

10 WIGLEY DRIVE McLAREN VALE Mob: 0448 656 254 Email: stevelaytondesign@bigpond.com ABN: 40 248 246 245

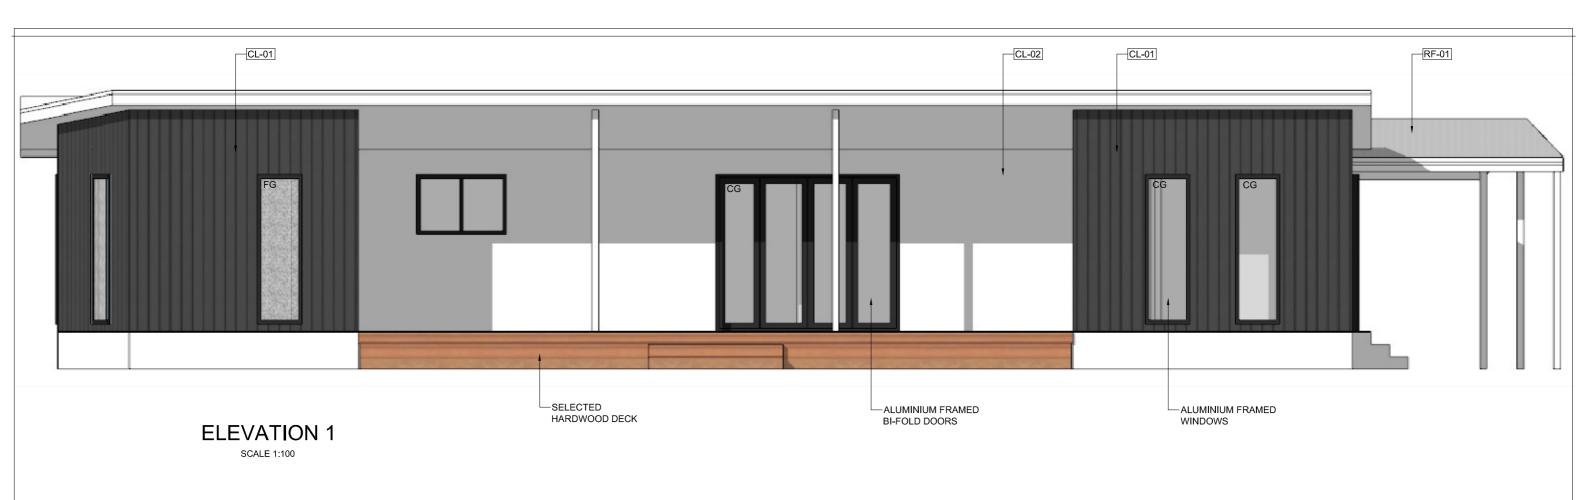

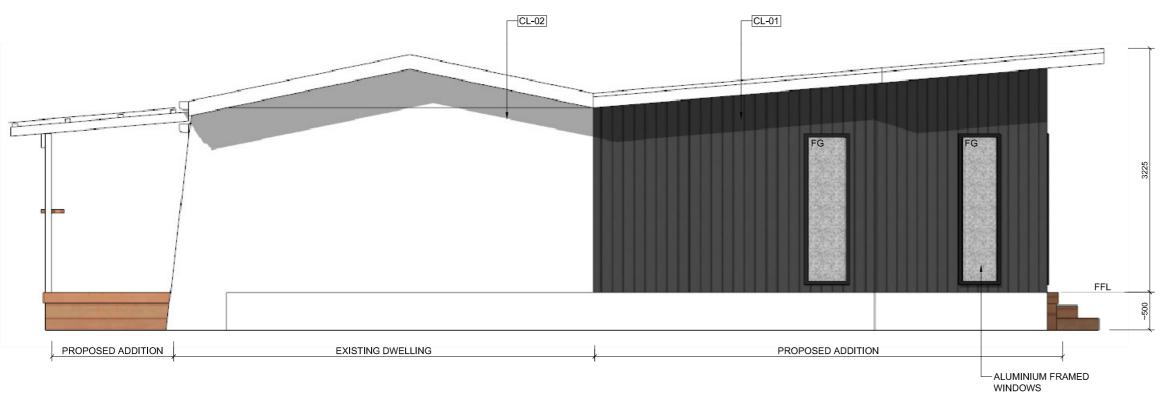

SCALE:

DATE:

	EXTERIOR FINISHES SCHEDULE
CL-01	CLADDING - AXON 133mm SMOOTH - MONUMENT
CL-02	REFURBISH EXISTING RENDERED WALLS - PAINT OFF-WHITE
RF-01	CLADDING COLORBOND CUSTOM ORB - SHALE GREY
PA-01	PAINTED FINISH - OFF WHITE
CG	CLEAR GLASS
FG	FROSTED GLASS
	ALL WINDOW AND DOOR FRAMES - MONUMENT

CONFIRM ALL COLOURS AND FINISHES WITH OWNER PRIOR TO PROCUREMENT

ELEVATION 2

SCALE 1:50


PROJECT: Addition to Existing Dwelling CLIENT: Mike and Trinh Richards

SITE ADDRESS: 5 Shephard Road ALDINGA BEACH SA 5173

Rev. Remarks **ELEVATIONS** ssued for Planning Approval 5APR22 1:50 UNO S.LAYTON DRAWN BY: 5 Apr2022


steve laytondesign SHEET 3 OF 17

10 WIGLEY DRIVE McLAREN VALE Mob: 0448 656 254

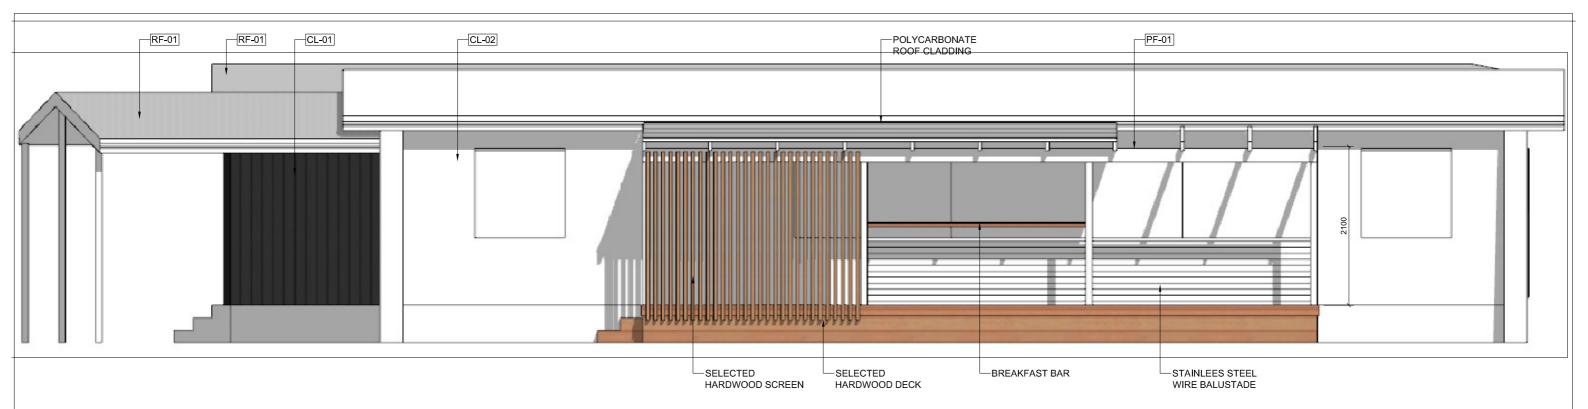

ELEVATION 3

SCALE 1:100

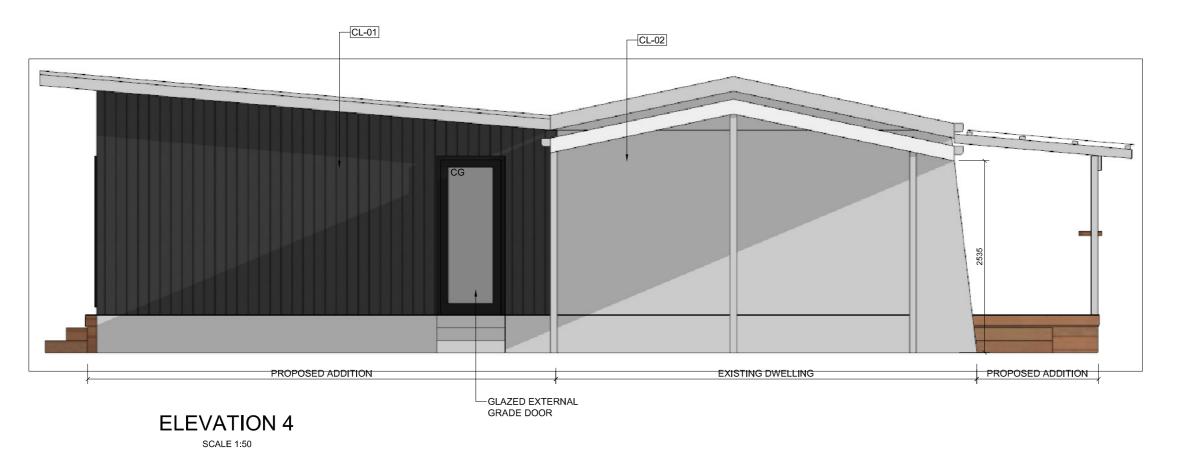

	EXTERIOR FINISHES SCHEDULE
CL-01	CLADDING - AXON 133mm SMOOTH - MONUMENT
CL-02	REFURBISH EXISTING RENDERED WALLS - PAINT OFF-WHITE
RF-01	CLADDING COLORBOND CUSTOM ORB - SHALE GREY
PA-01	PAINTED FINISH - OFF WHITE
CG	CLEAR GLASS
FG	FROSTED GLASS
	ALL WINDOW AND DOOR FRAMES - MONUMENT

CONFIRM ALL COLOURS AND FINISHES WITH OWNER PRIOR TO PROCUREMENT

PROJECT: Addition to Existing Dwelling

CLIENT: Mike and Trinh Richards

SITE ADDRESS: 5 Shephard Road ALDINGA BEACH SA 5173

ELEVATIONS

SCALE: 1:50 UNO
DRAWN BY: S.LAYTON
DATE: 5 Apr2022

Rev. Remarks Date
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SHEET 4 OF 17
10 WIGLEY DRIVE

McLAREN VALE

Mob: 0448 656 254 Email: stevelaytondesign@bigpond.com



SITE ADDRESS: 5 Shephard Road ALDINGA BEACH SA 5173

SCALE: DRAWN BY: N.T.S. S.LAYTON 5 Apr2022 DATE:

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В	Issued for Building Approval	2AUG22	l
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WALL FRAMING & BEAM LAYOUT SCALE 1:100

WALLS

ALL FRAMING TO COMPLY WITH AS1684

90x45 10mm MAX. TRENCHING or 90x35 WITHOUT TRENCHING TOP PLATE: BOTTOM PLATE: 90x45 10mm MAX. TRENCHING or 90x35 WITHOUT TRENCHING 90x35 AT 600 MAX. CENTRES GENERAL STUDS:

AT 450 MAX. CENTRES WET AREAS

90x35 AT 1350 MAX. CENTRES NOGGINGS:

JAMB STUDS EACH SIDE OF OPENINGS:

- OPENINGS UP TO 1200mm - 1/90x45

- OPENINGS 1200mm TO 2400mm - 2/90x35 - OPENINGS 2400mm TO 3300mm - 2/90x45

- OPENINGS 3300mm TO 4000mm - 3/90x35

- OPENINGS 4000mm TO 4500mm - 3/90x45

STUDS SUPPORTING CONCENTRATED LOADS:

S145 - 1/90x45 S235 - 2/90x35 S245 - 2/90x45 S345 - 3/90x45 S445 - 4/90x45

POSTS: P1 - 90x90 F7 - H3 TREATED PINE POSTS

STUDS TO BE LOCATED DIRECTLY BELOW TRUSSES AND RAFTERS OR WITHIN 60mm UNLESS RIBBON PLATE IS USED TO ALLOW RANDOM PLACEMENT OF TRUSSES

ALL TIMBER FRAMING TO BE MINIMUM MGP10 OR F7 PINUS RADIATA TREATED TO H2 UNLESS NOTED OTHERWISE

FIXINGS

3.05mm x 75mm LONG NAILS

TOP PLATE TO STUD:

2 SKEWED NAILS PER STUD BOTTOM PLATE TO STUD: 2 SKEWED NAILS PER STUD

BRACING TABLE						
WIND DIRECTION	PROJECTED AREA m2	PRESSURE kPa	FORCE kN	TOTAL RESISTANCE		
1	33	0.92 (N2)	30.4	32.4		
\leftrightarrow	11	0.92 (N2)	10.1	19.1		


NOTE: THIS DOES NOT INCLUDE EXISTING BRACING.

LEGEND

- NEW TIMBER FRAME WALLS

- MODIFIED EXISTING WALLS

- LINTELS

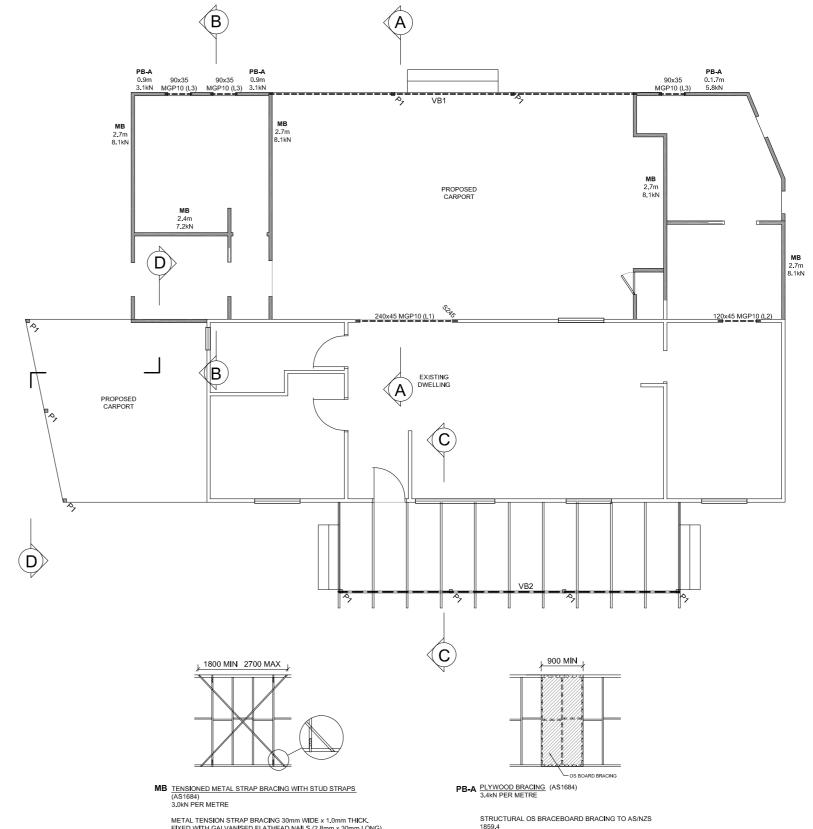

METAL TENSION STRAP BRACING 30mm WIDE x 1.0mm THICK, FIXED WITH GALVANISED FLATHEAD NAILS (2.8mm x 30mm LONG)

STUDS - 1 NAIL
TOP AND BOTTOM PLATES - 2 NAILS ON PLATE EDGE, 4 NAILS
ON STRAP WRAPPED OVER TOP PLATE AND UNDER
BOTTOM PLATE.
BRACING IS TO BE TENSIONED AFTER INSTALLATION.

METAL STRAP 30mm WIDE x 0.8mm THICK. LOOPED OVER PLATE AND FIXED TO STUD WITH 4VGALVANISED FLATHEAD NAILS (2.8mm x 30mm LONG) EACH END

1859.4 BOARD TO BE FIXED WITH GALVANISED FLATHEAD NAILS (2.8mm x 30mm LONG)
TOP AND BOTTOM EDGES - NAILS AT 150mm SPACING. VERTICAL EDGES - NAILS AT 150mm SPACING. INTERMEDIATE STUDS - NAILS AT 300mm SPACING

SHEET 6 OF 17

PROJECT: Addition to Existing Dwelling CLIENT: Mike and Trinh Richards

SITE ADDRESS: 5 Shephard Road ALDINGA BEACH SA 5173

Remarks Date WALL FRAMING LAYOUT Issued for Planning Approval 5APR22 Issued for Building Approval SCALE: 1:100 UNO DRAWN BY: S.LAYTON DATE: 5 Apr2022



10 WIGLEY DRIVE McLAREN VALE Mob: 0448 656 254

ROOF FRAMING LAYOUT

SCALE 1:100

RB1 - - 240x63 LVL or 290x45 MGP10 or 2/240x35 MGP10 VB1 - 200x63 LVL or 210x55 GL13 or 125PFC VB2 - 190x45 MGP10 BEAMS:

VB3 - 240x35 MGP10 VB4 - 140x45 MGP10

R1- 290x45 MGP10 AT 1200 MAX CTS. ADJUST SPAN TO SUIT 6M LENGTH AND ADD OUTRIGGERS FOR EAVES RAFTERS:

or 240x63 LVL AT 1200 MAX CTS

R2- 120x45 MGP10 AT 900 MAX CTS.

WALL PLATE: WP1- 120x35 FIXED TO WALL WITH BUGLE SCREWS AT 600 CTS


90x45 ON FLAT AT 900 MAX. CENTRES (NOT SHOWN) PURLINS:

90x35 AT 600 MAX. CENTRES UP TO 1700 SPAN (NOT SHOWN) CEILING JOISTS: 90x45 AT 600 MAX. CENTRES UP TO 2200 SPAN (NOT SHOWN)

FACSIAS: 188x30 LOSP PRIMED

ALL TIMBER FRAMING TO BE F7 OR MGP10 PINUS MINIMUM GRADE FIX BEAMS AND RAFTERS TOGETHER WITH "JOIST HANGER BRACKETS"

TIE DOWN SCHEDULE		/IND SPEED N2 (33mps)
CODE	TIE DOWN	NOTES
TD01	BATTENS TO RAFTERS	PURLIN TO RAFTER 1/100MM NO. 14 TYPE 17 SCREW
TD02	TRUSS TO WALL FRAME	TRIPLE GRIP TO BOTH SIDES or 1/30x0.8 GI STRAP OVER RAFTER WITH 4xØ2.8 NAILS EACH END ON ALL RAFTERS
TD03	TOP AND BOTTOM PLATE	1/30x0.8 GI STRAP OVER TOP AND BOTTOM PLATES AND ALONG STUD 250mm MIN. WITH 6xØ2.8 NAILS EACH END- EVERY 2nd STUD
	FOR OPENINGS	1/30x0.8 GI STRAP OVER TOP AND BOTTOM PLATES AND ALONG STUD 250mm MIN. WITH 6xØ2.8 NAILS EACH END. 1/30x0.8 GI STRAP OVER TOP PLATE AND DOWN LINTEL WITHIN 100mm OF EACH RAFTER WITH 6xØ2.8 NAILS EACH END. M10 BOLT or 2/100MM NO. 14 TYPE 17 SCREWS EACH SIDE OF OPENINGS
	BEAM TO TIMBER POST	USE 2/M10 GALV BOLTS TO TIMBER POSTS
TD04	BOTTOM PLATE TO JOIST	1/100MM NO. 14 TYPE 17 SCREW AT 1200 MAX CENTRES
	JOIST TO BEARER	TRIPLE GRIP TO ONE SIDE or 1/30x0.8 GI STRAP OVER RAFTER WITH 3xØ2.8 NAILS EACH END ON ALL JOISTS
	BEARER STUMP	2/M10 GALV BOLTS THROUGH BEARER AND STUMP

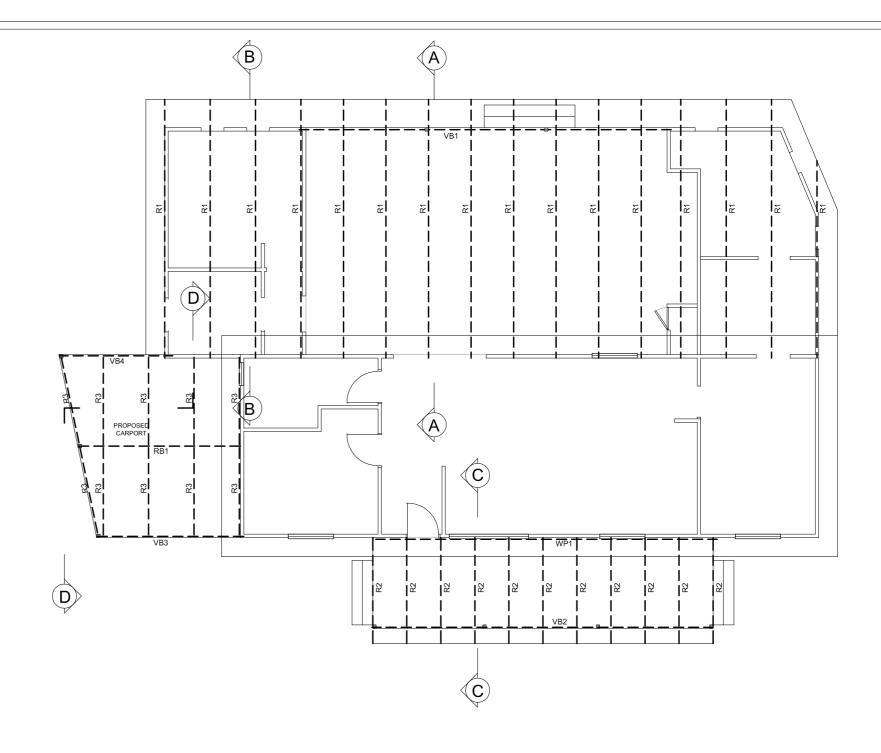

PROJECT: Addition to Existing Dwelling CLIENT: Mike and Trinh Richards

SITE ADDRESS: 5 Shephard Road ALDINGA BEACH SA 5173

ROOFING LAYOUT

SCALE: 1:100 UNO DRAWN BY: S.LAYTON DATE: 5 Apr2022



A Issued for Planning Approval

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SHEET 7 OF 17

10 WIGLEY DRIVE McLAREN VALE Mob: 0448 656 254

FLOORING LAYOUT

SCALE 1:100

BEARERS: BR1 = 2/140x35 MGP10 H3 TREATED PINE or 130x63 LVL

BR2 = 2/190x35 MGP10 H3 TREATED PINE or 200x63 LVL

FOOTINGS/STUMPS: P1 = 90x90 H3 TREATED PINE POSTS ON STIRRUPS / H4 IF EMBEDED IN

CONCRETE

P2 = 90x90 H3 TREATED PINE STUMPS ON STIRRUPS / H4 IF EMBEDED IN

CONCRETE

P3 = 90x90 H3 TREATED PINE POSTS ON STIRRUPS / H4 IF EMBEDED IN

CONCRETE

FLOOR JOISTS: FJ1 = 120x45 MGP10 H3 TREATED PINE AT 450 MAX. CENTRES


FLOORING: 19mm YELLOWTOUNGE STUCTAFLOR

DECKING JOISTS: DJ1 = 120x35 MGP10 H3 TREATED PINE AT 450 MAX. CENTRES

DJ2 = 140x45 MGP10 H3 TREATED PINE AT 450 MAX. CENTRES

DECKING: 120x19 - TO BE SELECTED BY OWNER

FIX DECKING TO FLOOR JOISTS WITH MINIMUM 50x2.8 TWIST SHANK GALV NAILS OR SCREWS.

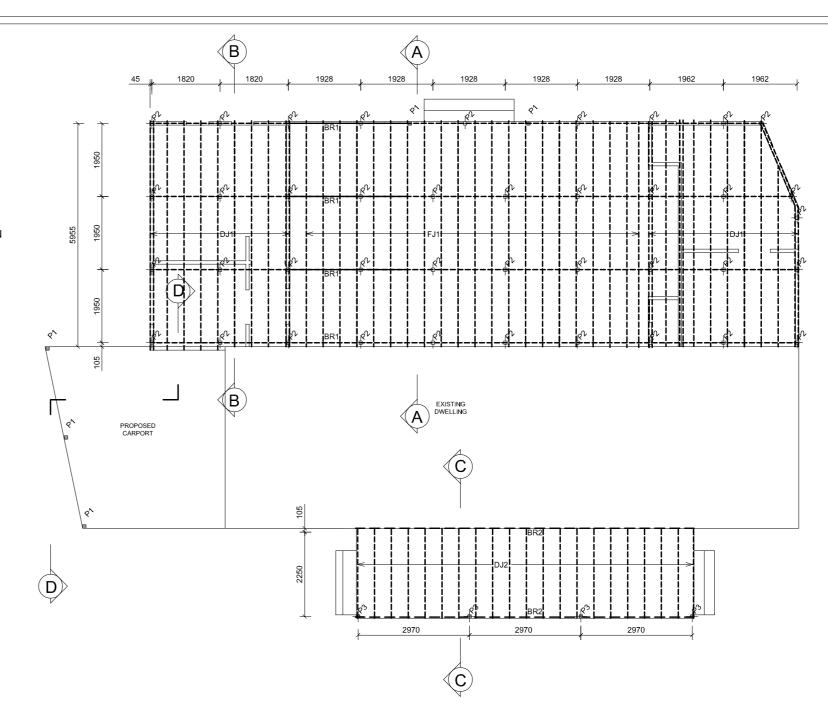

SHEET 8 OF 17

PROJECT: Addition to Existing Dwelling CLIENT: Mike and Trinh Richards

SITE ADDRESS: 5 Shephard Road ALDINGA BEACH SA 5173

FLOORING LAYOUT

1:100 UNO

S.LAYTON

5 Apr2022

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DATE:

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A Issued for Planning Approval 5APR22

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Remarks

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10 WIGLEY DRIVE McLAREN VALE Mob: 0448 656 254

Mob: 0448 656 254 Email: stevelaytondesign@bigpond.com ABN: 40 248 246 245

FOOTING LAYOUT

SCALE 1:50

- 1. FOOTING BEAMS TO BE FOUNDED A MINIMUM OF 100MM INTO NATURAL GROUND.
- 2. FLEXIBLE CONNECTIONS TO BE USED FOR PLUMBING AND STORMWATER PIPES.
- 3. PIPES TO BE LAGGED WITH 20mm CLOSED CELL POLYETHYLENE OR SIMILAR.
- 4. PIPES NEAR BASE OF TRENCH MUST HAVE A MINIMUM OF 100m OF CONCRETE BELOW PIPE TO BE CONTINUES FOR 1M EACH SIDE OF PIPE.
- 5. FOOTINGS TO NCC Table 3.2.5.7b 'Dimensions and reinforcement for strip footing systems for Class M-D sites'

FOOTING SCHEDULE						
BEAM	BEAM SIZE REINFORCEMENT					
SF1	300W x 500D	3-N12 TOP & BOTTOM	N/A			

CONCRETE GRADE N20




P1 = \emptyset 600x750 DEEP N20 CONCRETE FOOTINGS FOUNDED MIN. 150mm INTO FIRM NATURAL SOIL



P2 = \emptyset 450x750 DEEP N20 CONCRETE FOOTINGS FOUNDED MIN. 150mm INTO FIRM NATURAL SOIL



P3 = Ø450x750 DEEP N20 CONCRETE FOOTINGS FOUNDED MIN. 150mm INTO FIRM NATURAL SOIL

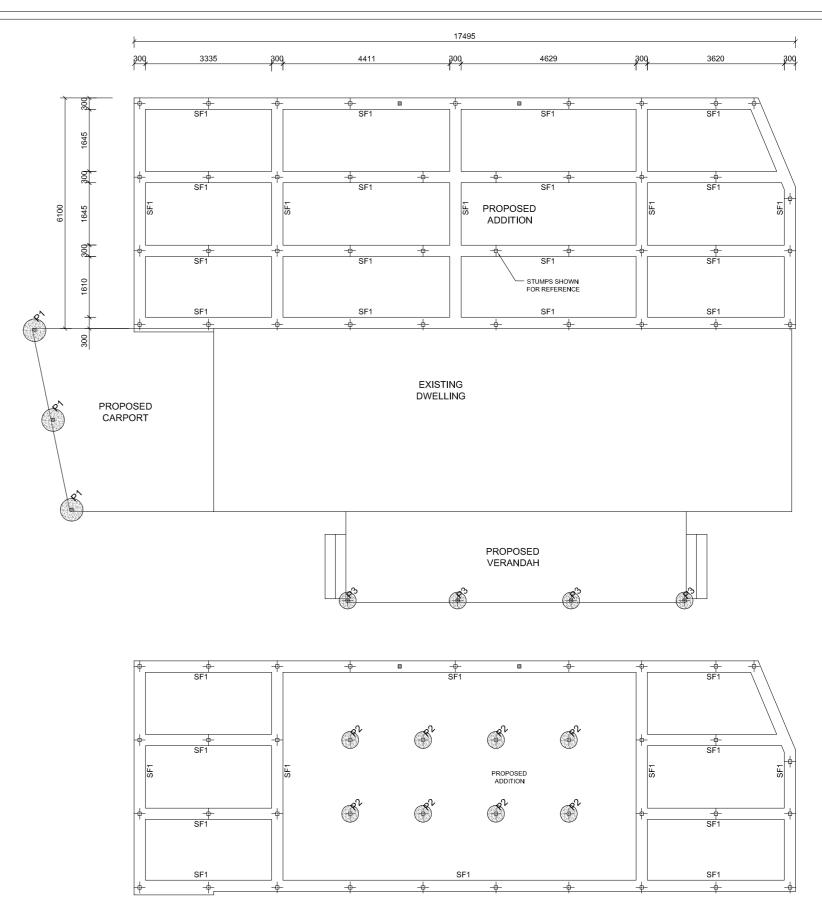

OPTIONAL FOOTING LAYOUT

SCALE 1:50


SHEET 9 OF 17


PROJECT: Addition to Existing Dwelling CLIENT: Mike and Trinh Richards

SITE ADDRESS: 5 Shephard Road ALDINGA BEACH SA 5173



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SHEET 11 OF 17

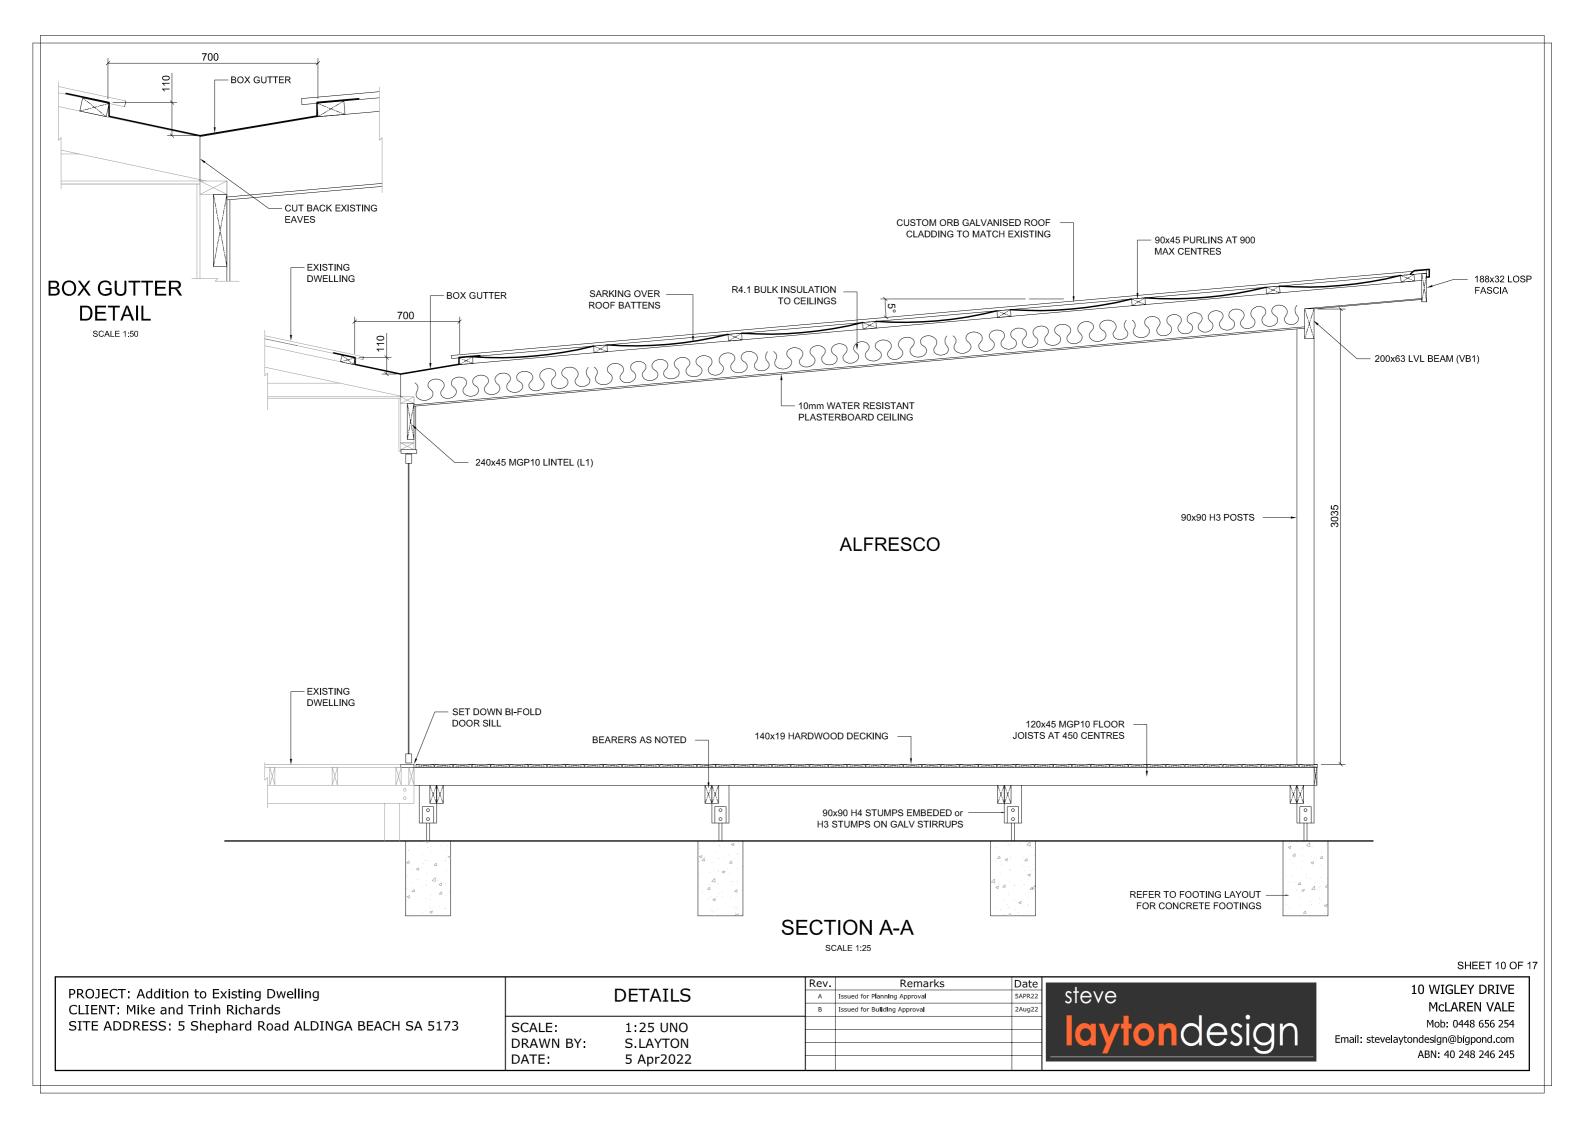
PROJECT: Addition to Existing Dwelling CLIENT: Mike and Trinh Richards

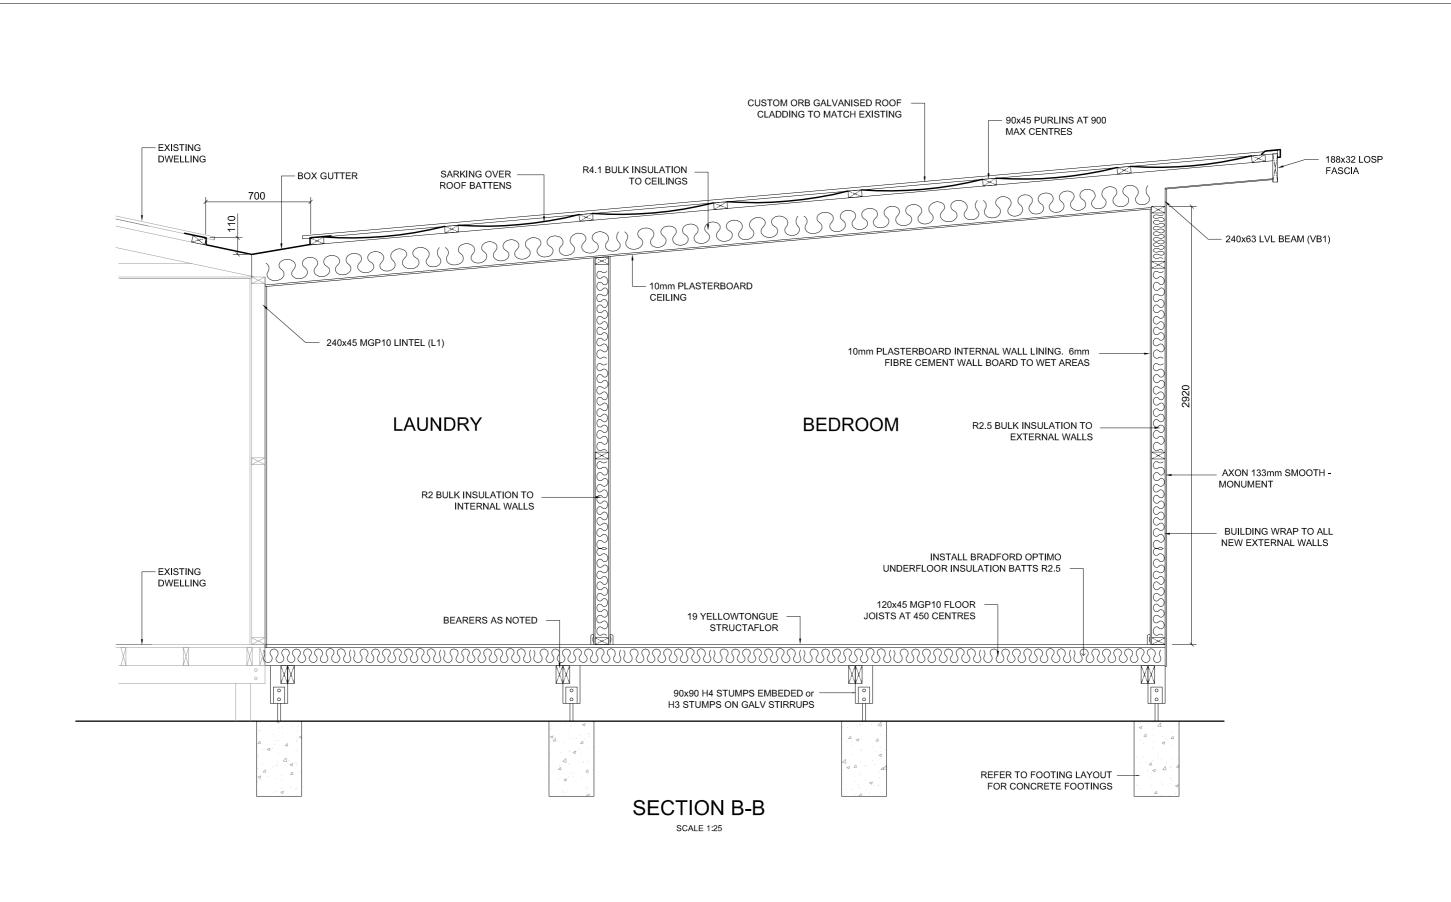SITE ADDRESS: 5 Shephard Road ALDINGA BEACH SA 5173

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	DETAILS	Α	Issued for Planning Approval	5APR22	1
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DATE:	5 Apr2022				ľ



10 WIGLEY DRIVE McLAREN VALE Mob: 0448 656 254

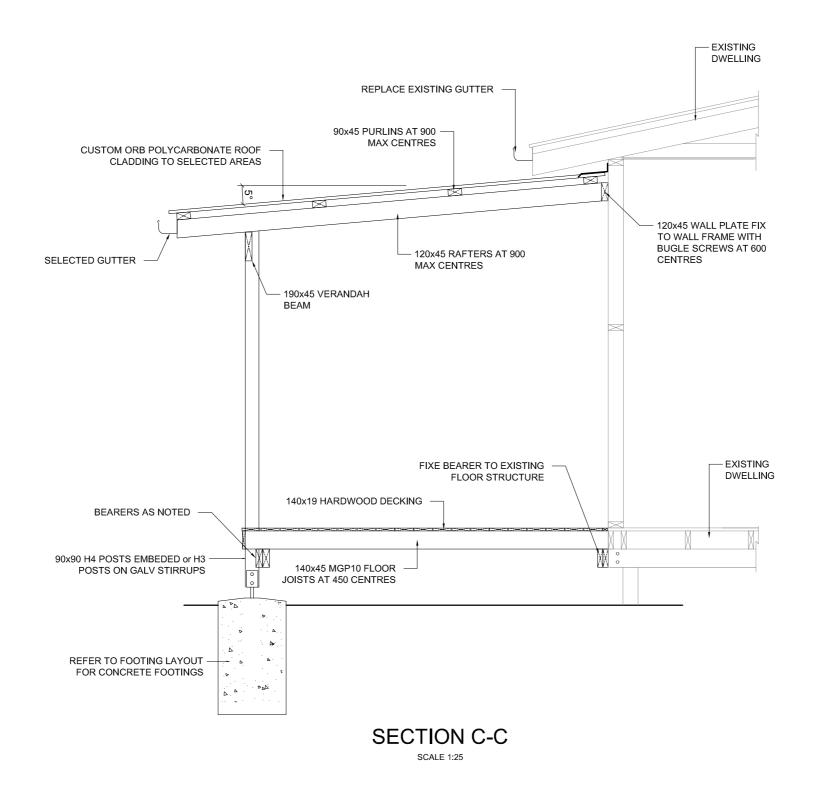

SHEET 12 OF 17


PROJECT: Addition to Existing Dwelling CLIENT: Mike and Trinh Richards

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	DETAILS		Α	Issued for Planning Approval		5APR22
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DRAWN BY:	S.LAYTON					
DATE:	5 Apr2022	ŀ				-



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SECTION D-D

SCALE 1:25

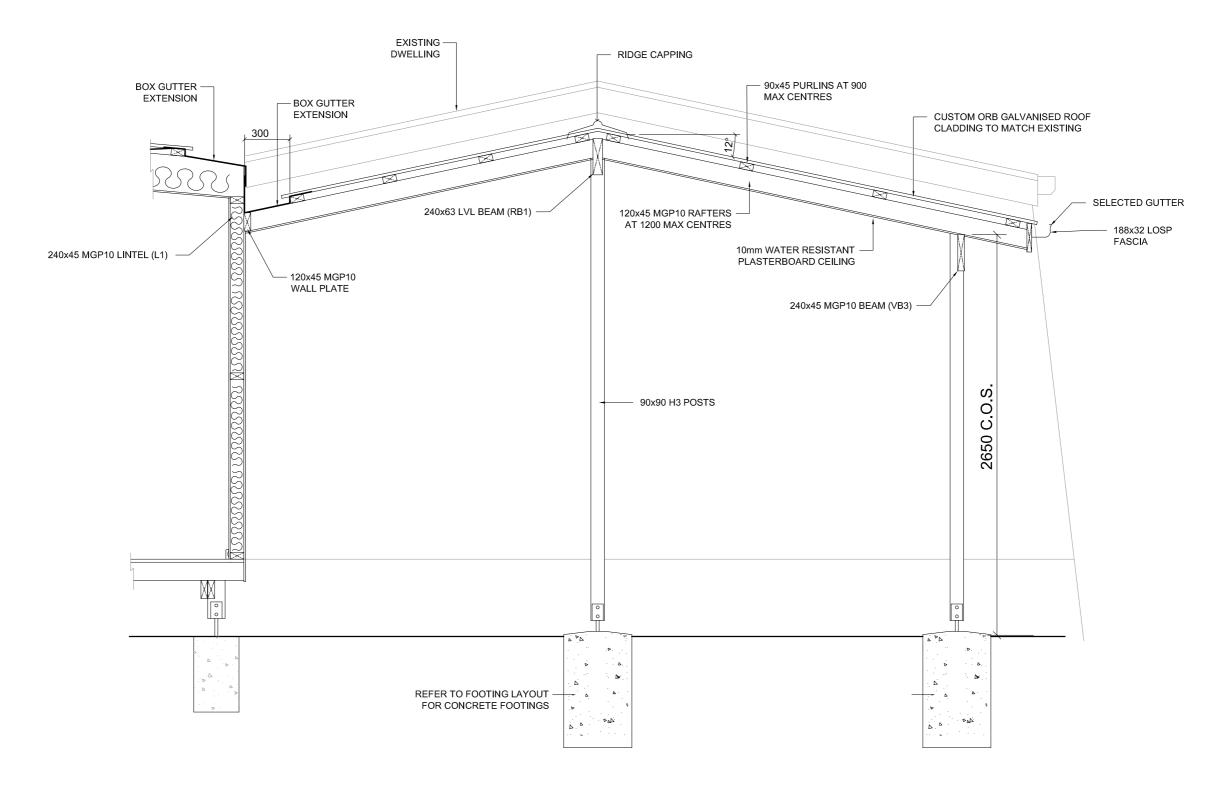SHEET 13 OF 17

PROJECT: Addition to Existing Dwelling CLIENT: Mike and Trinh Richards

SITE ADDRESS: 5 Shephard Road ALDINGA BEACH SA 5173

		Rev.	Remarks	Date
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		В	Issued for Building Approval	2Aug22
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DATE:	5 Apr2022			
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10 WIGLEY DRIVE McLAREN VALE Mob: 0448 656 254

Email: stevelaytondesign@bigpond.com

WASTE WATER LAYOUT

SCALE 1:100

FALL: DN100 MINIMUM FALL 1:60

DN65 MINIMUM FALL 1:40

FLOOR WASTE: EN-SUITE - 65DN FLOOR

WASTE GULLY WITH 80DN RISER

SHOWER: EN-SUITE - 80x50 TAPERED

GRATE WITH 50DN UNTRAPPED WASTE

VANITY BASIN: DN40 TRAPPED WASTE

BATH: DN40 TRAPPED WASTE

KITCHEN SINK: DN50 DOUBLE BOWL CONNECTOR

AND TRAF

TOILET: 100DN

ALL PLUMBING WORKS MUST BE IN ACCORDANCE WITH AS/NZS 3500.

ALL DETAILS TO BE CONFIRMED ON SITE BY PLUMBER. IF IN DOUBT

CONTACT STEVE LAYTON DESIGN

LEGEND



- INSPECTION SHAFT TO 100mm OF SURFACE 100DN



- INSPECTION OPENING 100DN



- OVERFLOW RELIEF GULLY 100DN

DN100


- VENT 50DN UPSTREAM
- SEWER DRAIN 100DN

DN65

- SEWER DRAIN 65DN

- SEWER DRAIN EXISTING

(E) - EXISTING

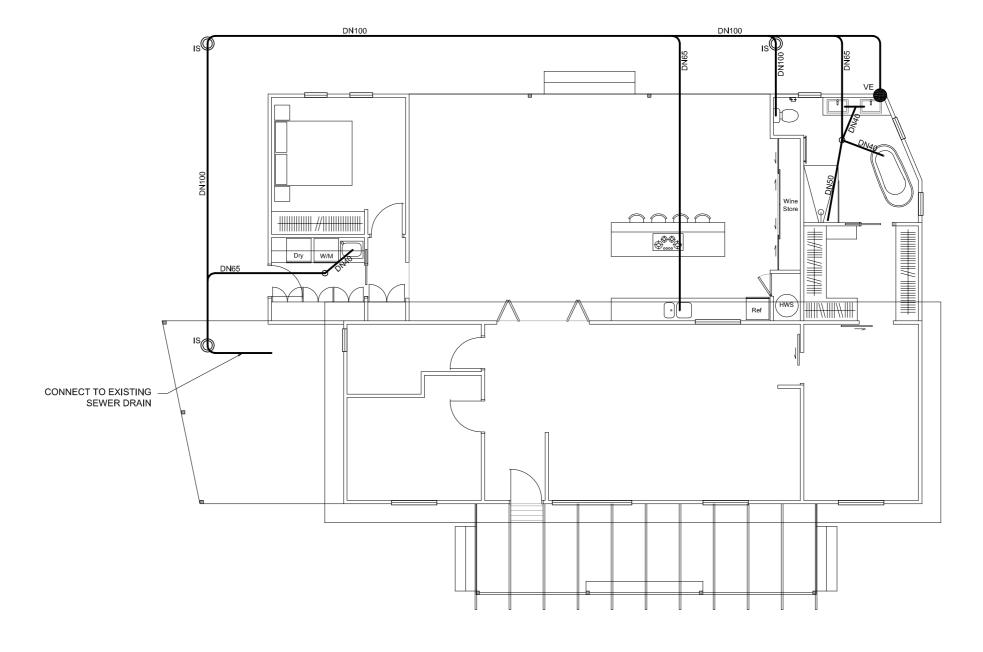

SHEET 14 OF 17

PROJECT: Addition to Existing Dwelling CLIENT: Mike and Trinh Richards


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WASTEWATER LAYOUT

SCALE: 1:100 UNO DRAWN BY: S.LAYTON DATE: 5 Apr2022 Rev. Remarks Date
A Issued for Planning Approval 5APR22
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10 WIGLEY DRIVE
McLAREN VALE
Mob: 0448 656 254
Email: stevelaytondesign@bigpond.com



LIGHTS

- STANDARD LIGHT

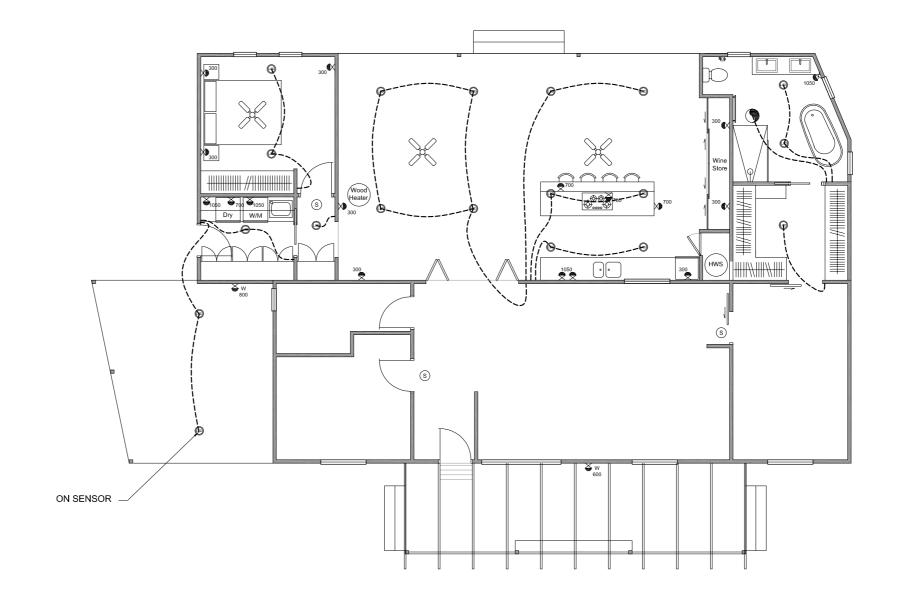- SEALED LED DOWNLIGHT

- WALL MOUNTED LIGHT

ELECTRICAL

- DOUBLE POWERPOINT

☼ - SINGLE POWERPOINT

- DOUBLE P/POINT WEATHERPROOF

→ SINGLE P/POINT WEATHERPROOF

• EXHAUST FAN

s - SMOKE DETECTOR

- SPLIT SYSTEM AIR CONDITIONER

X

- CEILING FAN

- CEILING FAN WITH LED LIGHT

SP

- SPEAKER

→ TV OUTLET

- COOKTOP ISOLATION SWITCH

ELECTRICAL LAYOUT

SCALE 1:100

NOTE:
BUILDER TO CONFIRM ELECTRICAL LAYOUT WITH
OWNER PRIOR TO INSTALLATION

SHEET 15 OF 17

PROJECT: Addition to Existing Dwelling

CLIENT: Mike and Trinh Richards

SITE ADDRESS: 5 Shephard Road ALDINGA BEACH SA 5173

ELECTRICAL LAYOUT

SCALE: 1:100 UNO DRAWN BY: S.LAYTON DATE: 5 Apr2022

Rev. Remarks Date

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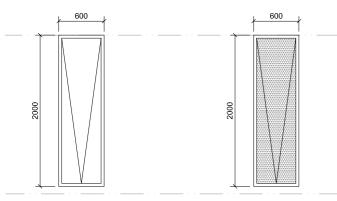
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10 WIGLEY DRIVE


McLAREN VALE

Moh: 0448 656 254


Mob: 0448 656 254 Email: stevelaytondesign@bigpond.com ABN: 40 248 246 245



W3, W4 -2000x600 ALUMINIUM AWNING WINDOW SINGLE GLAZING - OBSCURE QTY 2

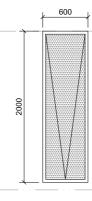

W5 -2000x600 ALUMINIUM FIXED WINDOW SINGLE GLAZING - OBSCURE

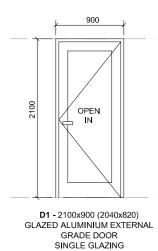


W1. W2 -2000x600


ALUMINIUM AWNING WINDOW


SINGLE GLAZING

QTY 2

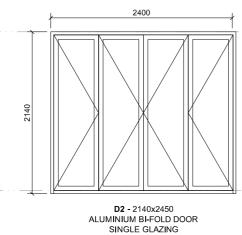

QTY 1

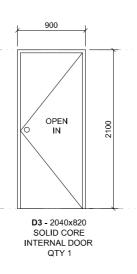

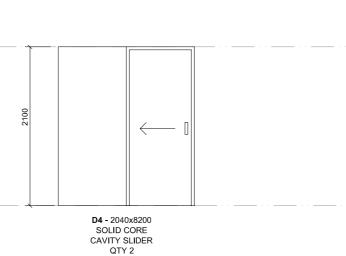

NOTE:


- 1. SITE MEASURE ALL WINDOWS & DOORS PRIOR TO MANUFACTURE
- 2. GLAZING PERFORMANCE VALUES TO BE U = 5.8max. and SHGC = 0.66 REFER TO ENERGY EFFICIENCY REPORT FOR DETAILS.
- 3. CONFIRM GLAZING REQUIREMENTS WITH OWNER

PROJECT: Addition to Existing Dwelling CLIENT: Mike and Trinh Richards

SITE ADDRESS: 5 Shephard Road ALDINGA BEACH SA 5173

WINDOW SCHEDULE

SCALE: 1:50 UNO
DRAWN BY: S.LAYTON
DATE: 5 Apr2022

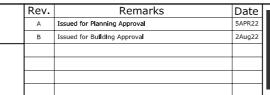



10 WIGLEY DRIVE


McLAREN VALE


Mob: 0448 656 254

Email: stevelaytondesign@bigpond.com

ABN: 40 248 246 245


SHEET 16 OF 17

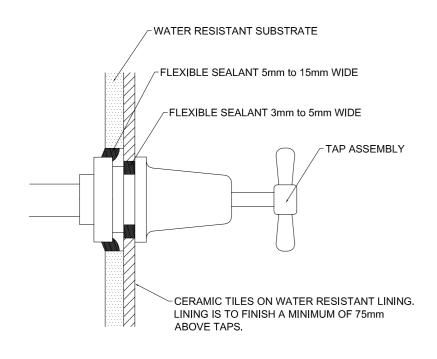

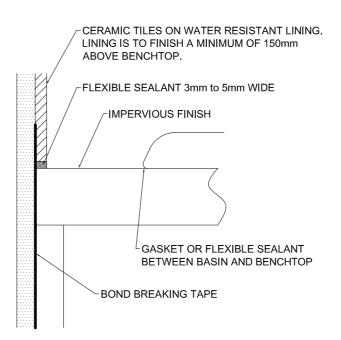

TAP PENETRATION OF IMPERVIOUS WALL

JUNCTION OF VANITY TOP AND IMPERVIOUS WALL

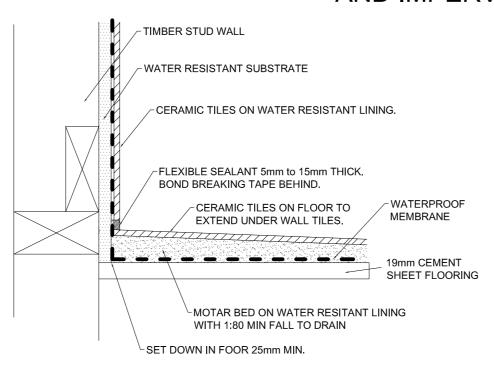

WET AREA AND SHOWER ALCOVE DETAIL - TIMBER FLOOR

SHEET 17 OF 17

PROJECT: Addition to Existing Dwelling CLIENT: Mike and Trinh Richards

SITE ADDRESS: 5 Shephard Road ALDINGA BEACH SA 5173

	DETAILO	Rev.	Remarks	Date
	DETAILS	А	Issued for Planning Approval	5APR22
		В	Issued for Building Approval	2Aug22
SCALE:	N.T.S.			
DRAWN BY:	S.LAYTON			
DATE:	5 Apr2022	<u> </u>		



10 WIGLEY DRIVE McLAREN VALE

Mob: 0448 656 254 Email: stevelaytondesign@bigpond.com